

DRAWING LEGEND

XX	ROOF DESIGNATION		GRAVITY VENT
RD	ROOF DRAIN		ABANDONED CHIMNEY
RD/CH/DS	ROOF DRAIN TO CONDUCTOR HEAD TO DOWNSPOUT		ROOF HATCH / ACCESS
	DRAIN SCUPPER TO CONDUCTOR HEAD AND DS		SKYLIGHT
	DRAIN SCUPPER		SLOPED GLAZING PANEL SYSTEM
DS	DOWNSPOUT		DUCT PENTRATION
PP	PITCH PAN		LIGHTING SYSTEM @ PP
FDC	FIRE DEPARTMENT CONNECTION		PERIMETER PARAPET WALL
HS	HOT STACK		RME PERIMETER
GN/HS	HOT STACK WITH GOOSE NECK		SATELLITE
VTR	VENT THROUGH ROOF		MECHANICAL UNIT ON SLEEPERS
WH	WEATHER HEAD		VENTILATOR
UNIT	MECHANICAL / HVAC UNIT		ROOF TIE-DOWN
	DUCT PENETRATION / CURB		LADDER

= ABANDONED EQUIPMENT / CURB TO BE REMOVED

GENERAL NOTES:


1. CONTRACTOR TO FIELD VERIFY ALL DIMENSIONS, PENETRATIONS, AND EXISTING ROOF CORE SUMMARY.
2. ALL ABANDONED EQUIPMENT TO BE REMOVED FROM EACH ROOF AREA AS IDENTIFIED ON EXISTING ROOF PLANS.

DEMOLITION NOTES:


1. DEMOLITION AND REMOVAL OF THE EXISTING LOW SLOPE BALLASTED EPDM ROOF SYSTEM DOWN TO THE ROOF DECK FOR REPLACEMENT WITH A SINGLE PLY ROOF SYSTEM.
2. ALL ABANDONED ROOF TOP EQUIPMENT TO BE REMOVED WITH THE ROOF DECK BEING PATCHED AS REQUIRED. REFER TO STRUCTURAL DRAWINGS FOR SUPPLEMENTAL FRAMING FOR NEW DECKING.
3. REMOVAL OF ALL EXISTING SHEET METAL AND ALL ASSOCIATED COMPONENTS INDICATED TO BE REPLACED WITH NEW.

EXISTING ROOF CORE SUMMARY

▲ XRX	CORE NUMBER AND IDENTIFIER
▲ XFX	FLASHING NUMBER AND IDENTIFIER
NR1	MODIFIED BITUMEN PERLITE POLYISOCYANURATE STEEL DECK TOTAL THICKNESS ABOVE DECK = 3-1/4"
NR2	MODIFIED BITUMEN PERLITE POLYISOCYANURATE STEEL DECK TOTAL THICKNESS ABOVE DECK = 3-1/4"
OR1	GBUR MEMBRANE WOOD FIBER POLYISOCYANURATE WOOD DECK TOTAL THICKNESS ABOVE DECK = 4"
OR2	GBUR MEMBRANE WOOD FIBER POLYISOCYANURATE WOOD DECK TOTAL THICKNESS ABOVE DECK = 4"
OR3	GBUR MEMBRANE WOOD FIBER POLYISOCYANURATE WOOD DECK TOTAL THICKNESS ABOVE DECK = 4"

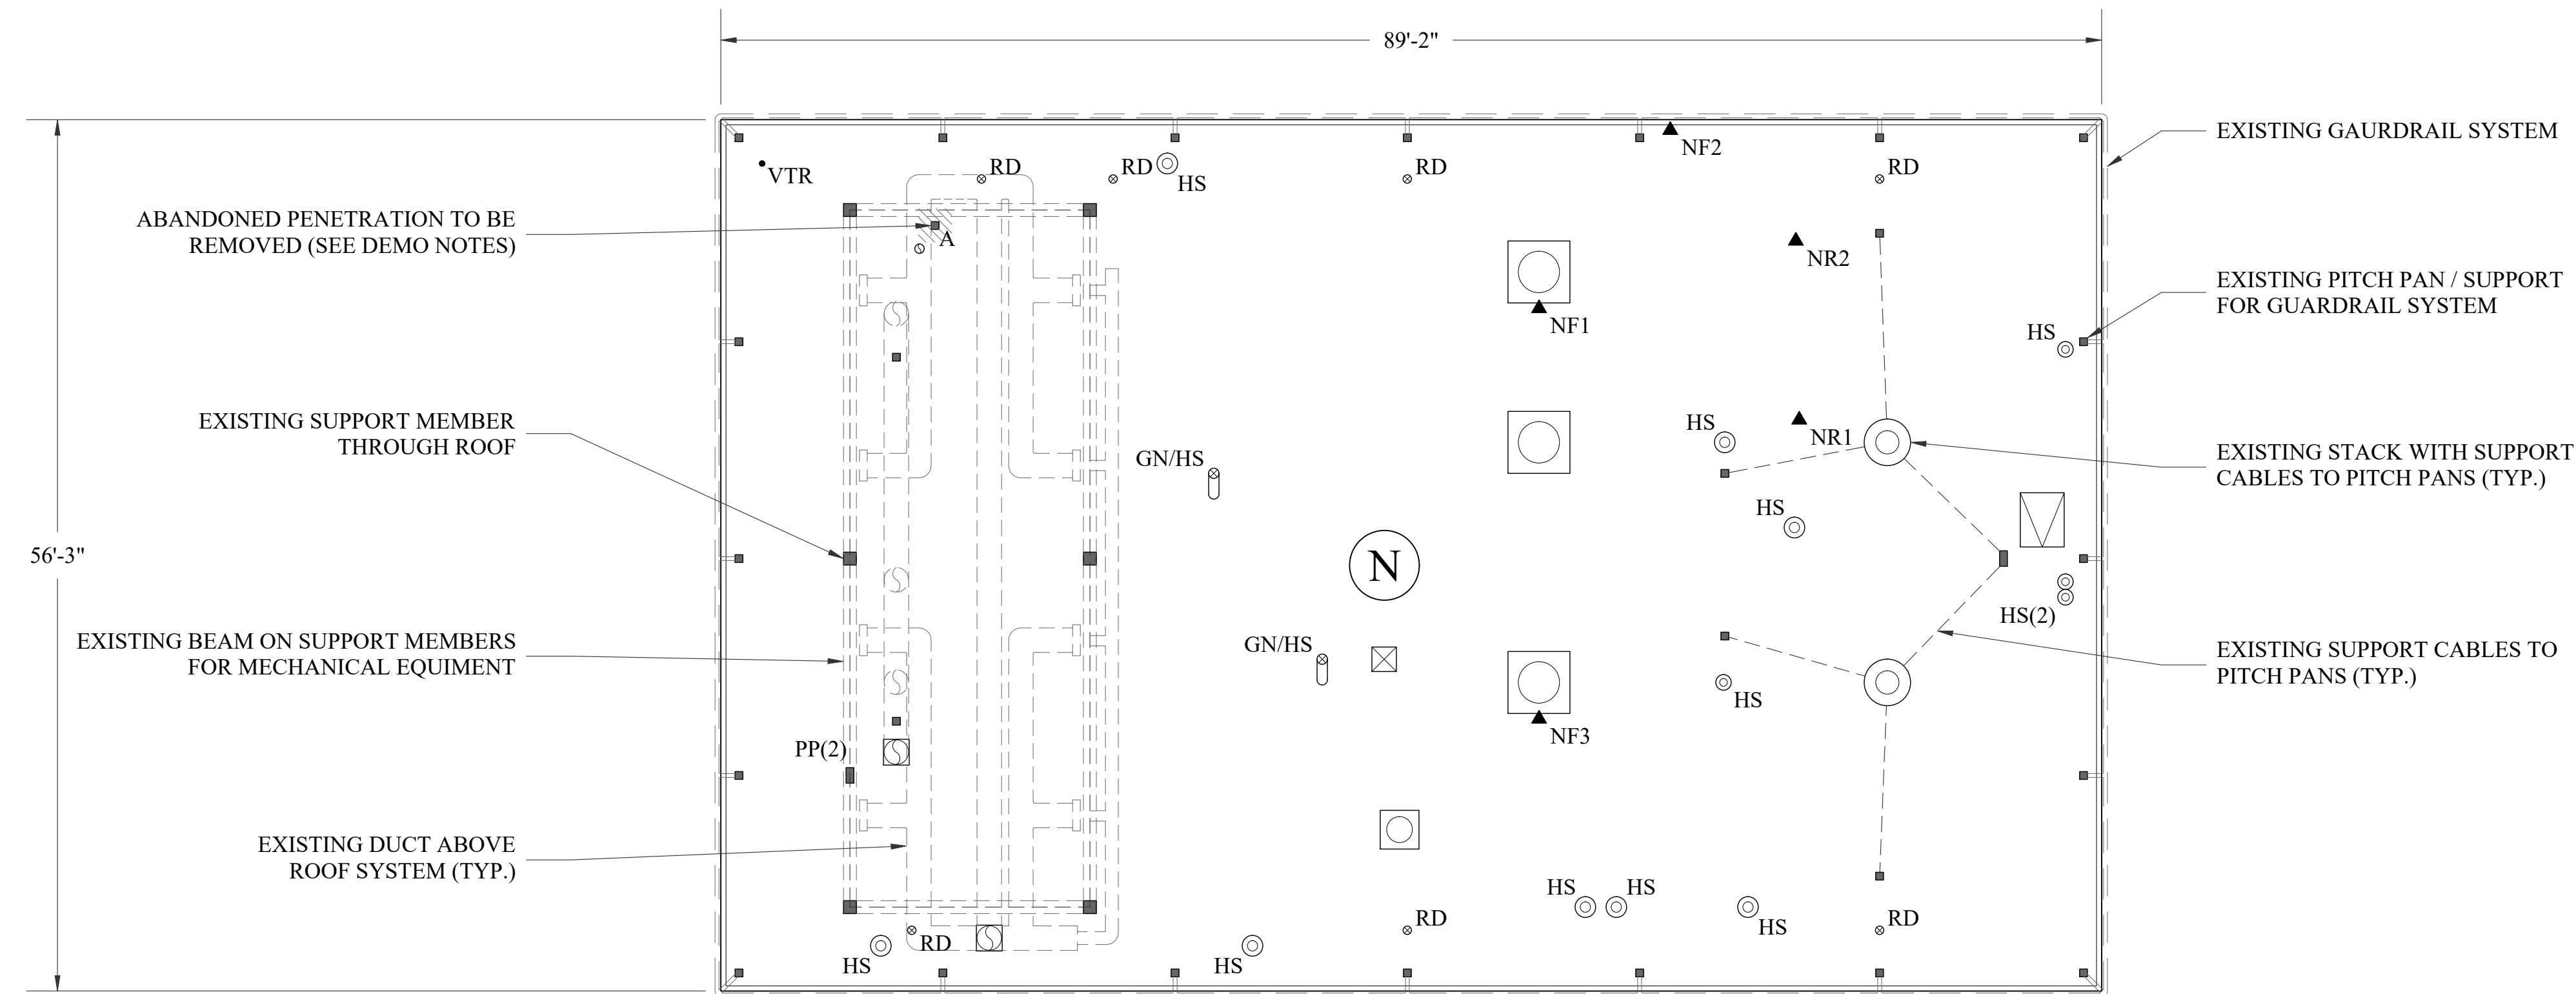

EXISTING ROOF PLAN - AREA "N" (ENERGY FACILITY)
1/8" = 1'-0"

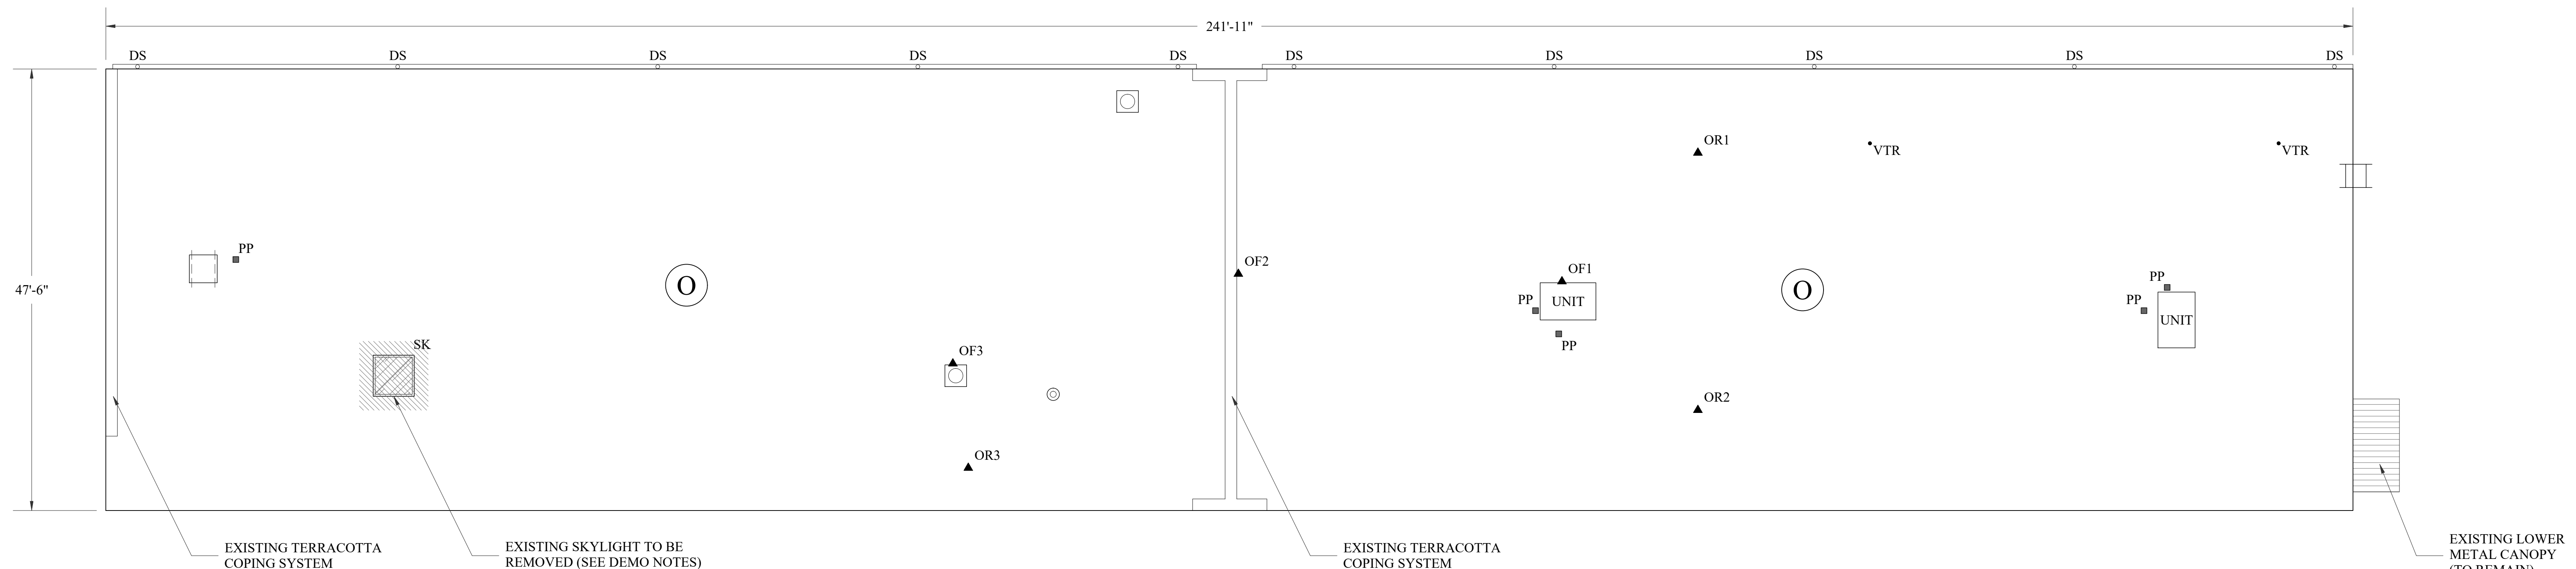


EXISTING ROOF PLAN - AREA "O"
1/8" = 1'-0"

issued for
CONSTRUCTION DOCUMENTS

date
APRIL 14, 2022

number	item	date

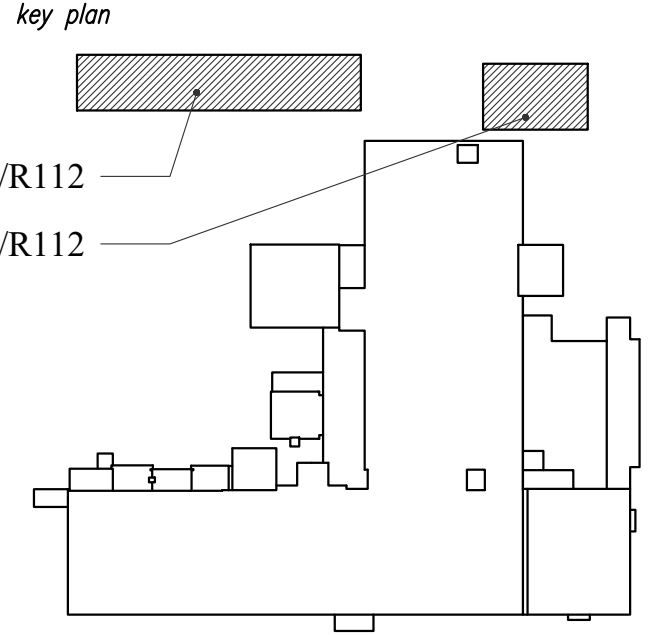

sheet title
EXISTING ROOF PLAN

sheet number
R012

drawn by PD
checked by CW